

DISCRETIONARY APPLICATION For Public Display

Applicant:

Smeekes Drafting Pty Ltd

Location:

644 Lower Marshes Road, Apsley

Proposal:

Resource Processing (Change of Use - Farm Shed to Distillery)

DA Number:

DA 2020 / 00033

Date Advertised:

30 June 2020

Date Representation Period Closes:

14 July 2020

Responsible Officer:

Jacqui Tyson (Senior Planning Officer)

Viewing Documents:

The relevant documents may be viewed at Council's website www.centralhighlands.tas.gov.au or at Council's Offices 19 Alexander Street, Bothwell & 6 Tarleton Street, Hamilton during normal office hours.

Representations to: General Manager

19 Alexander Street BOTHWELL TAS 7030

Email:

kbradburn@centralhighlands.tas.gov.au



Development & Environmental Services 19 Alexander Street BOTHWELL TAS 7030

Phone: (03) 6259 5503 Fax: (03) 6259 5722

www.centralhighlands.tas.gov.au

OFFICE USE ONLY	
Application No.:	
Property ID No.:	1
Date Received:	-

Application for Planning Approval Use and Development

Applicant / Ov	wner Details:			5 - cl s		
Applicant Name	Jay Weir					
Postal Address	12 Warwick Stre	et		Phone No:	03 6234	6185
	Hobart, Tasmani	а	7000	Fax No:		
Email address	jay.weir@smeel	kesdrafting.com.	au			
Owner/s Name (if not Applicant)	Corey Hazelwo	od & Lauren Haz	elwood			
Postal Address	644 Lower Marsl	nes Road		Phone No:	0423 00	7 844
	Apsley, Tasmani	а	7030	Fax No:		
Email address:	corey.h@hotmai	l.com				
Description of	proposed use and					Trade Martin
and development:	644 Lower Mars	hes Road, Apsle	y TAS 703	30		
Certificate of Title No:	Volume No 134822	2	Lot No: 1			
Description of proposed use or development:	Change of Use	- Farm Shed to \	Vhiskey D	istillery	/ /Shed / F	velling /Additions/ Demolition farm Building / Carport / Pool or detail other etc.
Current use of land and buildings:	Rural / Resident	ial			on this t	hat is the main building
	What are the proposed	·			d roof colour	N/A (existing)

is proposed development to be staged:	Yes	2	No	8	Tick /
is the proposed development located on land previously used as a tip site?	Yes		No	gt.	
Is the place on the Tasmanian Heritage Register?	Yes		No	7	
Have you sought advice from Heritage Tasmania?	Yes		No	8	
Has a Certificate of Exemption been sought for these works?	Yes		No	12	

Signed Declaration

I/we hereby apply for a planning approval to carry out the use or development described in this application and in the accompanying plans and documents, accordingly I declare that:

- 1. The information given is a true and accurate representation of the proposed development. I understand that the information and materials provided with this development application may be made available to the public. I understand that the Council may make such copies of the information and materials as, in its opinion, are necessary to facilitate a thorough consideration of the Development Application. I have obtained the relevant permission of the copyright owner for the communication and reproduction of the plans accompanying the development application, for the purposes of assessment of that application. I indemnify the Central Highlands Council for any claim or action taken against it in respect of breach of copyright in respect of any of the information or material provided.
- 2. In relation to this application, I/we agree to allow Council employees or consultants to enter the site in order to assess the application.
- 3. I am the applicant for the planning permit and I have notified the owner/s of the land in writing of the intention to make this application in accordance with Section \$2(1) of the Land Use Planning Approvals Act 1993 (or the land owner has signed this form in the box below in "Land Owner(s) signature); Applies where the applicant is not the Owner and the land is not Crown land or owned by a council, and is not load administered by the Crown or a council.

Applicant Signature (if not the Owner)	Applicant Name (Please print) Lay VVeir	0ste 10/06/2020
Land Owner(e) Sistemure	Land Owners Name (please print) Corey Hazelwood	Date /6/2.0
Larid Ovener(e) Signature	Land Owners Name (please pring) Lauren Hazelwood	0sto 11/6/2.0

Information & Checklist sheet 1. A completed Application for Planning Approval – Use and Development form. Please ensure that the information provides an accurate description of the proposal, has the correct Ø address and contact details and is signed and dated by the applicant. A current copy of the Certificate of Title for all lots involved in the proposal. The title details must include, where available, a copy of the search page, title plan, sealed plan or diagram Ø and any schedule of easements (if any), or other restrictions, including covenants, Council notification or conditions of transfer. Two (2) copies of the following information -An analysis of the site and surrounding area setting out accurate descriptions of the following -**1** topography and major site features including an indication of the type and extent of native vegetation present, natural drainage lines, water courses and wetlands, trees greater than 5 metres in height in areas of skyline or landscape importance and identification of any natural hazards including flood prone areas, high fire risk areas and land subject to instability; (ii) soil conditions (depth, description of type, land capability etc); (iii) the location and capacity of any existing services or easements on the site or connected to the site; (iv) existing pedestrian and vehicle access to the site; (v) any existing buildings on the site; (vi) adjoining properties and their uses; and (vii) soil and water management plans. b) A site plan for the proposed use or development drawn, unless otherwise approved, at a scale of not A less than 1:200 or 1:1000 for sites in excess of 1 hectare, showing -(i) a north point; (ii) the boundaries and dimensions of the site; (iii) Australian Height Datum (AHD) levels; (iv) natural drainage lines, watercourses and wetlands; (v) soil depth and type; (vi) the location and capacity of any existing services or easements on the site or connected to the site; (vii) the location of any existing buildings on the site, indicating those to be retained or demolished, and their relationship to buildings on adjacent sites, streets and access ways; (viii) the use of adjoining properties; (ix) shadow diagrams of the proposed buildings where development has the potential to cause overshadowing; (x) the dimensions, layout and surfacing materials of all access roads, turning areas, parking areas and footpaths within and at the site entrance; (xi) any proposed private or public open space or communal space or facilities; proposed landscaping, indicating vegetation to be removed or retained and species and mature heights of plantings; and (xiii) methods of minimizing erosion and run-off during and after construction and preventing contamination of storm water discharged from the site. c) Plans and elevations of proposed and existing buildings, drawn at a scale of not less than 1:100, V showing internal layout and materials to be used on external walls and roofs and the relationship of the elevations to natural ground level, including any proposed cut or fill. A written submission supporting the application that demonstrates compliance with the relevant parts of the Act, State Polices and the Central Highlands Interim Planning Scheme 2015, including for industrial and

4. A written submission supporting the application that demonstrates compliance with the relevant parts of the Act, State Polices and the Central Highlands Interim Planning Scheme 2015, including for industrial and commercial uses, the hours of operation, number of employees, details of any point source discharges or emissions, traffic volumes generated by the use and a Traffic Impact Statement where the development is likely to create more than 100 vehicle movements per day.


5. Prescribed fees payable to Council. An invoice for the fees payable will be issued once application has been received.

ū		
	Information	
	If you provide an email address in this form then the Central Highlands Council ("the Council") will treat the provision of the email address as consent to the Council, pursuant to Section 6 of the Electronic Transactions Act 2000, to using that email address for the purposes of assessing the Application under the Land Use Planning and Approvals Act 1993 ("the Act").	
	If you provide an email address, the Council will not provide hard copy documentation unless specifically requested.	
	It is your responsibility to provide the Council with the correct email address and to check your email for communications from the Council.	
	If you do not wish for the Council to use your email address as the method of contact and for the giving of information, please tick ✓ the box	
	Heritage Tasmania	
	If the Property is listed on the Tasmanian Heritage Register then the Application will be referred to Heritage Tasmania unless an Exemption Certificate has been provided with this Application. (Phone 1300 850 332 or email enquires@heritage.tas.gov.au)	
	TasWater	
	Depending on the works proposed Council may be required to refer the Application to TasWater for assessment (Phone 136992)	



RESULT OF SEARCH

RECORDER OF TITLES

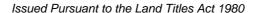



SEARCH OF TORRENS TITLE

VOLUME	FOLIO
134822	1
EDITION	DATE OF ISSUE
5	07-Jun-2012

SEARCH DATE : 15-May-2020 SEARCH TIME : 11.14 AM

DESCRIPTION OF LAND

Parish of SPRING HILL, Land District of MONMOUTH

Lot 1 on Plan 134822

Being the land described in Conveyance 72/4234

Derivation: Part of 115 acres, 200 acres and 500 acres,

Granted to John Bisdee Derived from Y19404

SCHEDULE 1

D23195 TRANSFER to COREY JON HAZELWOOD and LAUREN MICHELLE

HAZELWOOD Registered 08-Sep-2011 at 12.01 PM

SCHEDULE 2

Reservations and conditions in the Crown Grant if any

72/4234 BURDENING EASEMENT: Right of Carriageway [appurtenant

to Lot 1 on Diagram 46755) over the Right of Way six

metres wide shown on Plan 134822

D52458 MORTGAGE to Commonwealth Bank of Australia

Registered 07-Jun-2012 at 12.01 PM

UNREGISTERED DEALINGS AND NOTATIONS

No unregistered dealings or other notations




FOLIO PLAN

RECORDER OF TITLES




Issued Pursuant to the Land Titles Act 1980

Registered Number **CONVERSION PLAN** FILE NUMBER Y19404 LOCATION P.134822 GRANTEE MONMOUTH - SPRINGHILL PART OF (115AC, 200AC & 500AC), APPROVED II OCT 2000 GRANTED TO JOHN BISDEE CONVERTED FROM CONV 72/4234 Alice NOT TO SCALE LENGTHS IN METRES Recorder of Titles MAPSHEET MUNICIPAL CODE No. 105 (5030) ALL EXISTING SURVEY NUMBERS TO BE CROSS REFERENCED ON THIS PLAN 1900945 LAST UPI No. DRAWN DJB SKETCH BY WAY OF ILLUSTRATION ONLY "EXCEPTED LANDS"

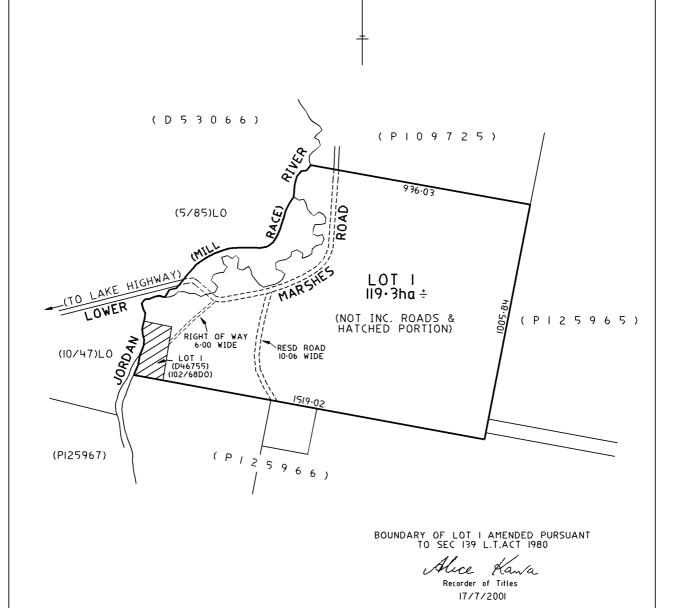

Search Date: 15 May 2020 Search Time: 11:14 AM Volume Number: 134822 Revision Number: 02 Page 1 of 1

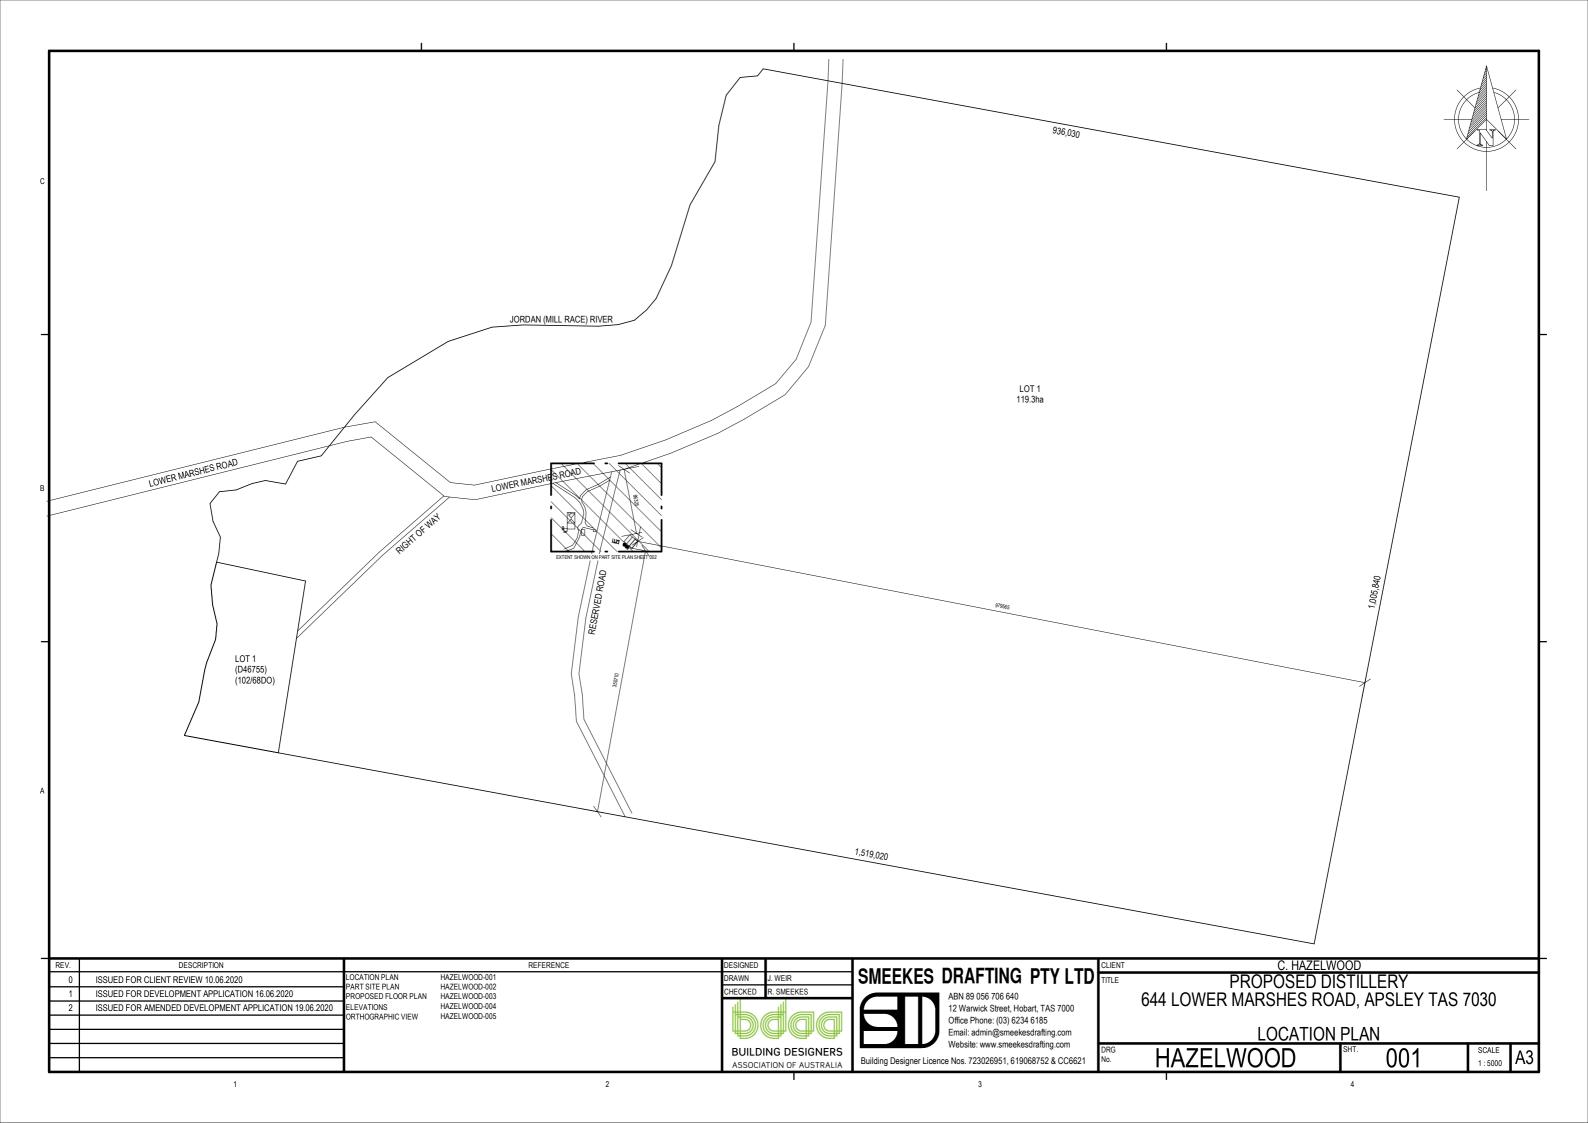

GENERAL NOTES:

- . THESE DRAWINGS ARE TO BE READ IN CONJUNCTION WITH SMEEKES DRAFTING PTY LTD STANDARD BUILDING NOTES, SHEETS STANDARD-001 TO 005.
- 2. WRITTEN DIMENSIONS TO TAKE PRECEDENCE OVER SCALE.
- 3. BUILDER TO VERIFY ALL BOUNDARY CLEARANCES AND SITE SET-OUT DIMENSIONS PRIOR TO COMMENCEMENT OF CONSTRUCTION.
- ALL CONSTRUCTION WORK SHALL BE UNDERTAKEN IN ACCORDANCE WITH THE BUILDING CODE OF AUSTRALIA AND RELEVANT AUSTRALIAN STANDARDS.
- 5. TIMBER FRAMING SHALL BE IN ACCORDANCE WITH THE REQUIREMENTS OF AS 1684.2 "TIMBER FRAMED CONSTRUCTION". T.P. DECK SHALL BE CONSTRUCTED IN ACCORDANCE WITH THE REQUIREMENTS OF THE PUBLICATION FROM THE TIMBER PROMOTION COUNCIL "TIMBER DECKS - DESIGN AND CONSTRUCTION MANI IAI "
- FOOTINGS AND SLABS SHALL BE IN ACCORDANCE WITH THE REQUIREMENTS OF AS 2870 "RESIDENTIAL SLABS AND FOOTINGS".
- PLUMBING AND DRAINAGE SHALL BE IN ACCORDANCE WITH AS 3500.2 AND AS 3500.3 "THE NATIONAL PLUMBING AND DRAINAGE CODE". FIT ADJUSTABLE TEMPERING VALVES TO ALL ABLUTIONS IN ACCORDANCE WITH AS 1529 "CODE OF PRACTICE OF HOUSEHOLD TYPE HOT WATER SUPPLY SYSTEMS".
- WATER PROOFING OF WET AREAS SHALL BE IN ACCORDANCE WITH THE REQUIREMENTS OF AS 3740 "WATERPROOFING OF WET AREAS IN RESIDENTIAL BUILDINGS".
- ELECTRICAL INSTALLATION SHALL BE IN ACCORDANCE WITH THE REQUIREMENTS OF AS/NZS 3000 "WIRING RULES". SMOKE ALARMS SHALL BE INSTALLED IN ACCORDANCE WITH TASMANIAN FIRE SERVICE AND AS 3786" SMOKE ALARMS".
- 10. GLAZING SHALL BE IN ACCORDANCE WITH AS 1288 "GLASS IN BUILDINGS SELECTION AND INSTALLATION", WINDOWS TO COMPLY WITH AS 2047 "WINDOWS IN BUILDINGS SELECTION AND INSTALLATION".
- MIN. R6.0 INSULATION TO CEILING. MIN. R2.5 INSULATION TO ALL EXTERNAL WALLS.
- ALL STEELWORK SHALL BE IN ACCORDANCE WITH AS 4100 "STEEL STRUCTURES".

SITE DATA:

LAND TITLE REF. No. : LOT 1 ON PLAN 134822

CLIMATE ZONE : ZONE 7
DESIGN WIND SPEED : T.B.A.
SOIL CLASSIFICATION : T.B.A.
BAL RATING : T.B.A.


THE RISK IS CONSIDERED TO BE VERY LOW (THERE IS INSUFFICIENT RISK TO WARRANT ANY SPECIFIC CONSTRUCTION REQUIREMENTS BUT THERE IS STILL SOME RISK.)

PROPOSED BUILDING AREAS:

DISTILLERY : 163.00m2

SITE COVERAGE:

LOT SIZE : 1,193,000.00m2 TOTAL FOOTPRINT : 451.00m2 SITE COVERAGE : 0.038%

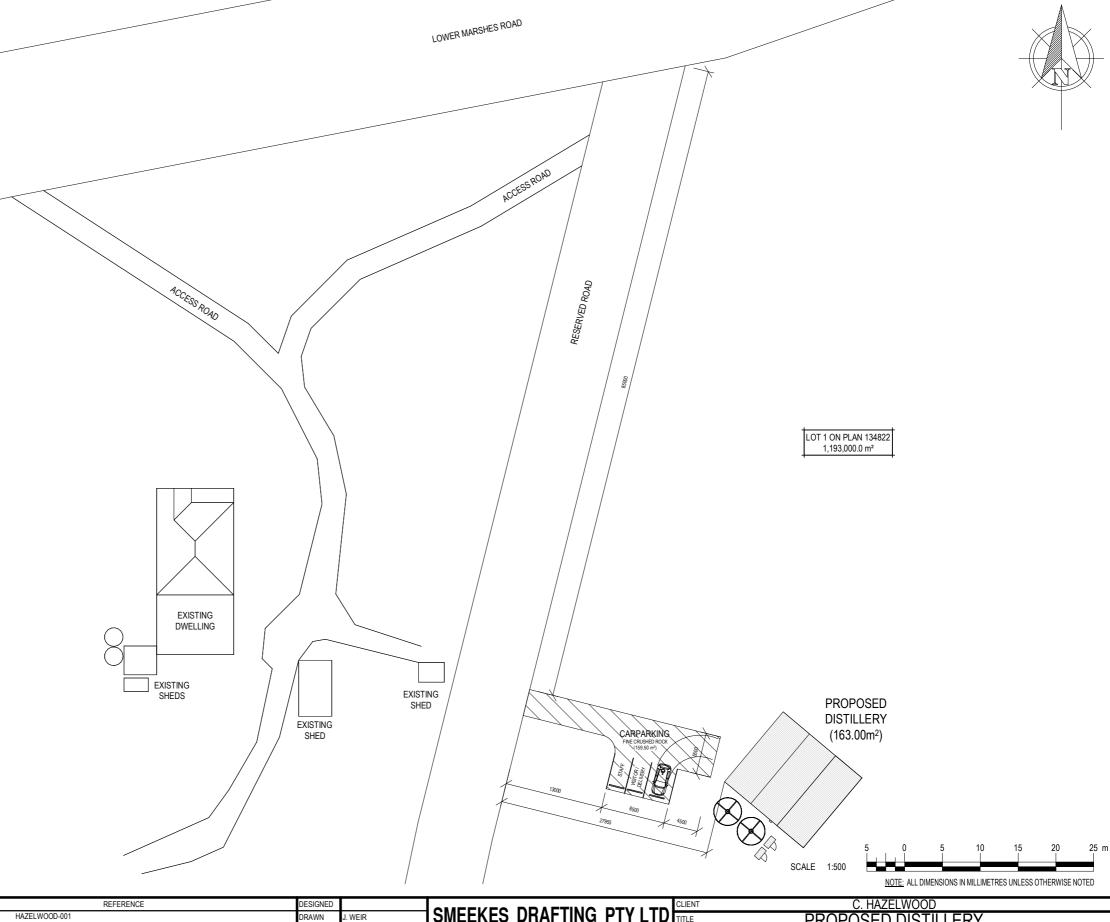


REV.	DESCRIPTION		REFERENCE	DESIGNED		OMERICEO DRAFTINO BEVILED	CLIENT	C. HAZEL	WOOD	
0		LOCATION PLAN HAZELWOOD-001 PART SITE PLAN HAZELWOOD-002		DRAWN		SMEEKES DRAFTING PTY LTD	TITLE	PROPOSED [DISTILLERY	
1		PROPOSED FLOOR PLAN HAZELWOOD-003		CHECKED	R. SMEEKES	ABN 89 056 706 640		644 LOWER MARSHES RO	-	V TAS 7030
2		ELEVATIONS HAZELWOOD-004 ORTHOGRAPHIC VIEW HAZELWOOD-005				12 Warwick Street, Hobart, TAS 7000		OTT LOWER MARKONEO IN	JAD, AI OLL	1 1/10 1000
		ORTHOGRAPHIC VIEW HAZELWOOD-005				Office Phone: (03) 6234 6185		DADT OIT	E DLAN	
						Email: admin@smeekesdrafting.com Website: www.smeekesdrafting.com		PART SIT	<u>E PLAN</u>	
				BUILDII	NG DESIGNERS	•	DRG	HAZELWOOD	SHT. 002	SCALE A3
				ASSOCIAT	TION OF AUSTRALIA	Building Designer Licence Nos. 723026951, 619068752 & CC6621	INU.	TIAZLLVVOOD	1 004	1:500
	1		2			3			4	

STAIRS / HANDRAIL NOTES:

- CLOSED TIMBER STAIRS CONSTRUCTED IN ACCORDANCE WITH BCA PART 3.9.1
- TREADS MUST HAVE A SLIP-RESISTANT FINISH OF A
 SUITABLE NON-SKID STRIP NEAR THE EDGE OF THE
 NOSINGS
- 3. RISER AND GOING DIMENSIONS IN ACCORDANCE WITH BCA PART 3.9.1.4.
 RISER (R) MAX. 190 MIN. 115
 GOING (G) MAX. 355 MIN. 240
 SLOPE RELATIONSHIP
 2R + G MAX. 700 MIN. 550
- 4. INSTALL HANDRAIL TO ONE SIDE OF FLIGHT IN ACCORDANCE WITH BCA PART 3.9.2.4.



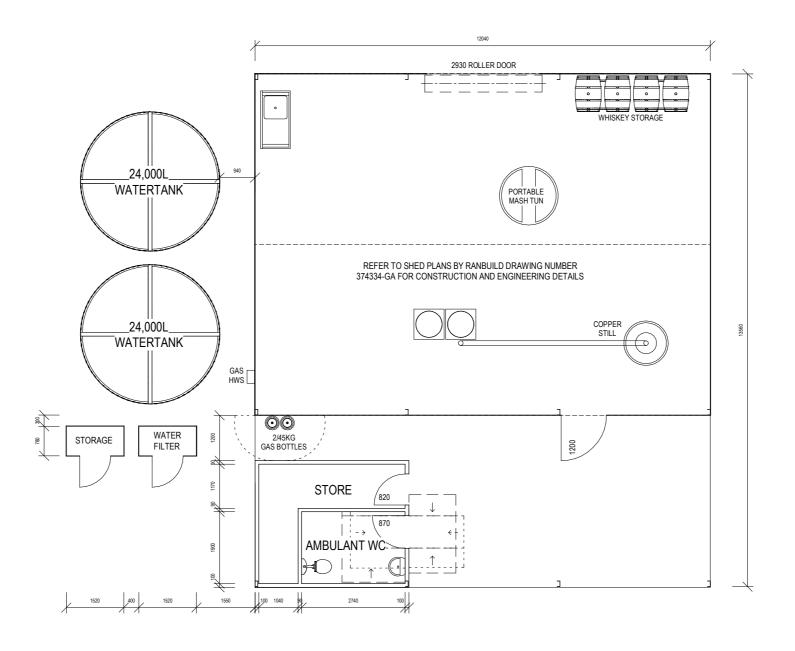





REV.	DESCRIPTION	REFERENCE	DESIGNED		CHECKEO DRAFTING DTV LTD CLIENT C. HAZELWOOD
0	ISSUED FOR CLIENT REVIEW 10.06.2020	LOCATION PLAN HAZELWOOD-001 PART SITE PLAN HAZELWOOD-002	DRAWN .	I. WEIR	SMEEKES DRAFTING PTY LTD PROPOSED DISTILLERY
1	ISSUED FOR DEVELOPMENT APPLICATION 16.06.2020	PROPOSED FLOOR PLAN HAZELWOOD-002	CHECKED F	R. SMEEKES	ABN 89 056 706 640 ABN 89 056 706 706 640 ABN 89 056 706 706 706 706 706 706 706 706 706 70
2	ISSUED FOR AMENDED DEVELOPMENT APPLICATION 19.06.2020	ELEVATIONS HAZELWOOD-004			12 Warwick Street, Hobart, TAS 7000
		ORTHOGRAPHIC VIEW HAZELWOOD-005			Office Phone: (03) 6234 6185
					Email: admin@smeekesdrafting.com PROPOSED FLOOR PLAN
			BUILDIN	NG DESIGNERS	Website: www.smeekesdraffing.com Building Designer Licence Nos. 723026951, 619068752 & CC6621 No. HAZELWOOD SHT. 003 SCALE 1: 100 A3
			ASSOCIAT	ION OF AUSTRALIA	Building Designer Licence Nos. 723026951, 619068752 & CC6621 No. TAZELVVOOD 11:100 A3

3



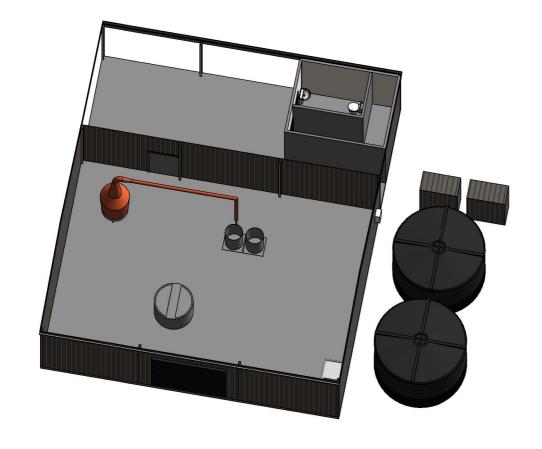

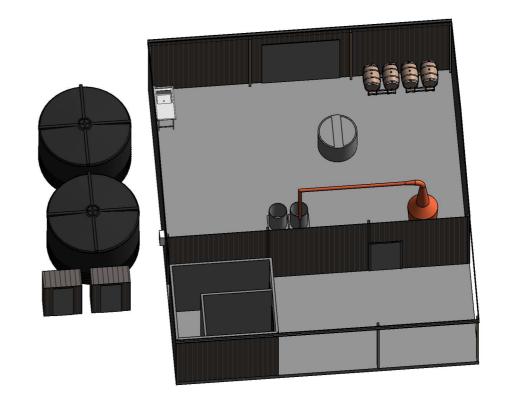

REV.	DESCRIPTION	REFERENCE	DESIGNED	OMERICEO DRAFTINO DEVITO	CLIENT C. HAZELWOOD
0	ISSUED FOR CLIENT REVIEW 10.06.2020	LOCATION PLAN HAZELWOOD-001 PART SITE PLAN HAZELWOOD-002	DRAWN J. WEIR	SMEEKES DRAFTING PTY LTD	PROPOSED DISTILLERY
1	ISSUED FOR DEVELOPMENT APPLICATION 16.06.2020	PROPOSED FLOOR PLAN HAZELWOOD-003	CHECKED R. SMEEKES	ABN 89 056 706 640	644 LOWER MARSHES ROAD, APSLEY TAS 7030
2	ISSUED FOR AMENDED DEVELOPMENT APPLICATION 19.06.2020	ELEVATIONS HAZELWOOD-004		12 Warwick Street, Hobart, TAS 7000	044 LOWER WARDIES ROAD, AFSELT TAS 1000
		ORTHOGRAPHIC VIEW HAZELWOOD-005		Office Phone: (03) 6234 6185	ORTHOOD A BUILD VIIE W
				Email: admin@smeekesdrafting.com Website: www.smeekesdrafting.com	ORTHOGRAPHIC VIEW
			BUILDING DESIGNERS		DRG HAZELWOOD SHT. 005 SCALE A3
			ASSOCIATION OF AUSTRALIA	Building Designer Licence Nos. 723026951, 619068752 & CC6621	TIAZELYVOOD 000 [^0]
	1	2	ı	3	4



Enquiries to: Alexander Filonov

24th August 2017

The Manager Ranbuild PO Box 170 HAMILTON NSW 2303

Dear Sir/Madam,

Re: STRUCTURAL ADEQUACY OF STEEL FRAMED BUILDING

Client: Corey Hazelwood Ranbuild Job No.: 374334 Type: Sundown Deluxe

Location: 644 Lower Marshes Road APSLEY TAS 7030

Plans: D9.2-E-B2.5, DAN-RO-B2.5, DCON-NB, 374334-GA, 374334-ES

Being a professional engineer within the meaning of the Building Code of Australia (A1.1) with BlueScope Lysaght Technology we have undertaken a structural analysis of the steel framed building as described above. These plans were analysed in accordance with Codes of Practice: AS/NZS 1170.1, AS/NZS 1170.2, AS4100, AS2870 and AS/NZS 4600.

Based on our structural analysis, we are satisfied that the standard engineering drawings attached are suitable for the above project with the following modification.

No modifications required.

Yours faithfully,

Alexander Filonov

MIEAust, CPEng, NPER 1296608 (Structural), RPEQ 8094, CC4719P, EC27759, 24332ES

Product Development Manager BlueScope Lysaght Technology

BlueScope is a trademark of BlueScope Steel Limited

BlueScope Steel Limited ABN 16 000 011 058

27 Sterling Road Minchinbury NSW 2770

Telephone +612 8887 5114 Facsimile +612 9675 4911 www.bluescopesteel.com



CERTIFICATE OF THE RESPONSIBLE DESIGNER

Section 94 Section 106 Section 129 Section 155

To:	Corey Hazelwood			Owner name	
	644 Lower Marshes Ro	ad		Address	Form 35
	APSLEY TAS		7030	Suburb/postcode	
Decimen detail			7000		
Designer detail	IS:				
Name	ALEVANDED EILONO			0.1	Engineer Civil,
Name:	ALEXANDER FILONO	V		Category:	Building Designer
Business name:	BLUESCOPE LYSAGH	IT TECH	NOLOGY	Phone No:	02 4962 4311
Business address:	27 Sterling Road	terling Road			
	MINCHINBURY NSW		2770	Fax No:	02 4962 3421
Licence No:	CC 4719P Emai	il address:	alexander.f	ilonov@blue	escopesteel.com
Details of the p	roposed work:				
Owner/Applicant	Corey Hazelwood			Designer's proje reference No.	ct 374334
Address:	644 Lower Marshes Ro	ad		Lot N	lo:
	APSLEY TAS		7030		
Type of work:	Building w	vork 🔽	Plum	nbing work	(X all applicable)
Description of wor	k:			-	
					/ alteration / addition /
New building					val / re-erection rage / stormwater /
				on-site waste	ewater management
				other)	kflow prevention /
	Design Work (Scope, limita	1	_		certificates)
Certificate Type:	Certificate	•	sible Practit		
	Building design		or Building [
	Structural design		or Civil Des	igner	
	Fire Safety design	Fire Engi		Dooignor	
	Civil design Hydraulic design		ineer or Civil Services Des		
	Fire service design		Services Des		
	Electrical design		Services Des		
	Mechanical design		Service Desi		
	Plumbing design			<u>-</u>	g Designer or Engineer
	Other (specify)			<u> </u>	
Deemed-to-Satisfy:		Performa	ance Solution	ı: X the	appropriate box)
Other details:					
Structural desig	n of Steel frame Reinfor	ced Con	crete Footi	ngs for new	building

Design documents provided) :							
The following documents are provided with this Certificate – Document description:								
Drawing numbers:	Prepared by: Ranbuild RDS	Date:						
D9.2-E-B2.5 DAN-RO-B2.5 D	OCON-NB 374334-GA 374334	I-ES						
Schedules:	Prepared by:	Date:						
Specifications:	Prepared by:	Date:						
Importance Level 2								
Computations:	Prepared by:	Date:						
Performance solution proposals:	Prepared by:	Date:						
Test reports:	Prepared by:	Date:						
Standards, codes or guideli process:	nes relied on in design							
BCA PLUS Architectural elevations and plan ONLY Alexander Filonov has not been engaged to undertake any geotechnical condition to determine site classification and any inspections of the work to ensure the drawings and specifications with this certificate are complied with.								
Any other relevant docume	ntation:							

Attribution as designer:

I ALEXANDER FILONOV am responsible for the design of that part of the work as described in this certificate;


The documentation relating to the design includes sufficient information for the assessment of the work in accordance with the *Building Act 2016* and sufficient detail for the builder or plumber to carry out the work in accordance with the documents and the Act;

This certificate confirms compliance and is evidence of suitability of this design with the requirements of the National Construction Code.

Designer: ALEXANDER FILONOV June 24/08/2017

Licence No: CC 4719P

Assessme	nt of Certifiable Works: (Ta	ısWater)						
not conside	Note: single residential dwellings and outbuildings on a lot with an existing sewer connection are not considered to increase demand and are not certifiable.							
If you canno	ot check ALL of these boxes, LE	AVE THIS SECTION E	BLANK.					
TasWater m	ust then be contacted to determ	nine if the proposed w	orks are Certifiable	e Works.				
I confirm that the proposed works are not Certifiable Works, in accordance with the Guidelines for TasWater CCW Assessments, by virtue that all of the following are satisfied:								
☐ The wo	orks will not increase the demand f	or water supplied by Ta	asWater					
	orks will not increase or decrease t ged into, TasWater's sewerage in		or toxins that is to be	e removed by, or				
	orks will not require a new connect Water's infrastructure	ion, or a modification to	an existing connec	tion, to be made				
☐ The wo	orks will not damage or interfere wi	th TasWater's works						
☐ The wo	orks will not adversely affect TasW	ater's operations						
☐ The wo	ork are not within 2m of TasWater's	s infrastructure and are	outside any TasWa	ter easement				
□ I have	checked the LISTMap to confirm t	ne location of TasWate	r infrastructure					
	roperty is connected to TasWater'd for to TasWater.	s water system, a wate	r meter is in place, c	or has been				
Certification	n:							
I ALEXANDER FILONOV being responsible for the proposed work, am satisfied that the works described above are not Certifiable Works, as defined within the <i>Water and Sewerage Industry Act 2008</i> , that I have answered the above questions with all due diligence and have read and understood the Guidelines for TasWater CCW Assessments.								
Note: the Guid www.taswater	delines for TasWater Certification of com.au	of Certifiable Works As	sessments are avail	able at:				
	Name: (print)	Signe	ed	Date				
Designer:	ALEXANDER FILONOV	Duna		24/08/2017				

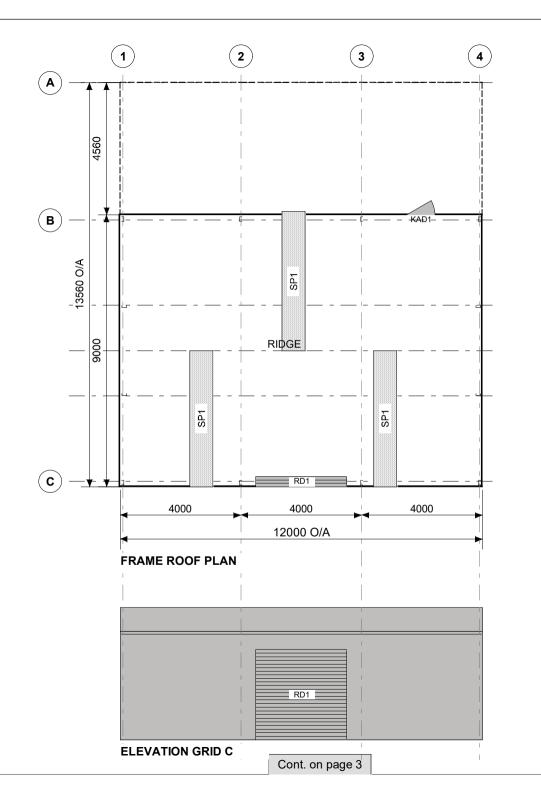



Copyright 2017 Lysaght Building Solutions Pty Ltd trading as RANBUILD

CLADDING				
ITEM	PROFILE (min)	FINISH	COLOUR	
ROOF	CUSTOM ORB 0.42 BMT	СВ	SH	
WALLS	CUSTOM ORB 0.42 BMT	СВ	SH	
CORNERS	-	СВ	SH	
BARGE	-	СВ	SH	
GUTTER	HI-QUAD	СВ	SH	

0.35bmt=0.40tct; 0.42bmt=0.47tct; 0.48bmt=0.53tct

	Α	ACCESSORY SCHEDULE & LEGEND			
	QTY	MARK	DESCRIPTION		
	1	RD1	B&D, Firmadoor, R.D, Residential "R1F", 2925 high x 3000 wide Clear Opening C/B		
2	1	KAD1	Premium (TA650DO) Access Door Kit, C/B (D). (Not Available in WA)		
Cont. on page	3	SP1	Sheeting, Polycarbonate, Corrugated Profile (SGFGS/AFCB)		
d uo					
i.i.					
ပ					

ARCHITECTURAL DRAWING ONLY, NOT FOR CONSTRUCTION USE

WIND DESIGN				
IMPORTANCE LEVEL REGION TERRAIN Ms				
2	Α	2	1.0	

CLIENT

Corey Hazelwood

644 Lower Marshes Road **APSLEY TAS 7030**

BUILDING

SUNDOWN DELUXE 9000 SPAN x 3600 EAVE x 12000 LONG **PLUS 4560 ANNEXE**

TITLE

GENERAL ARRANGEMENT


SCALE A4 SHEET 1:125

DRAWING NUMBER 374334-GA

PAGE 1/4




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SCALE A4 SHEET 1:125

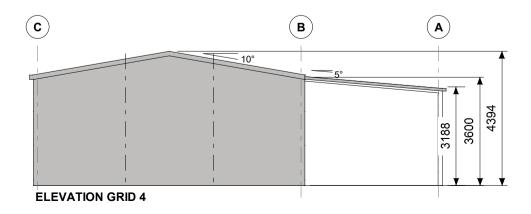DRAWING NUMBER 374334-GA

PAGE **2/4**



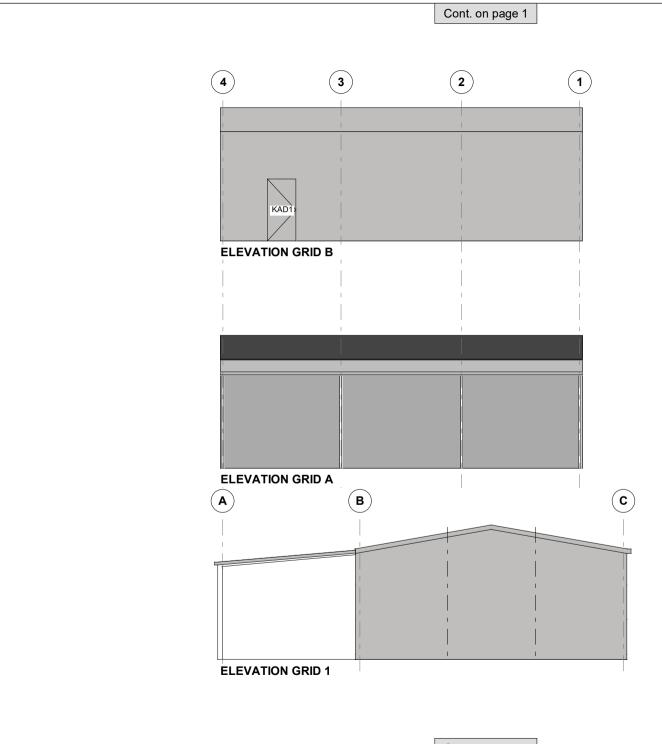

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DRAWING NUMBER 374334-GA

PAGE


3/4

Cont. on page 3



Better sheds. Bigger choice.

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SCALE A4 SHEET 1:125

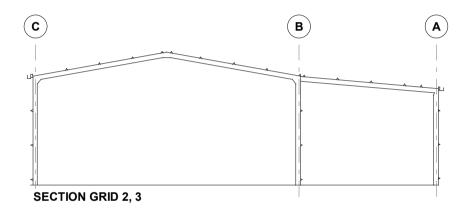CERTIFICATION

O THIS DRAWING IS VALID ONLY WHEN ENDORSED BY A SEPARATE DESIGN CERTIFICATE FROM

THAT IS VALID FOR THE DATE OF ISSUE AND CONSTRUCTION. THIS DRAWING SHALL BE READ IN CONJUNCTION WITH THE ENGINEERING LAYOUT AND CONNECTIONS DRAWINGS.

GENERAL

- ALL MATERIALS AND WORKMANSHIP TO COMPLY WITH THE RELEVANT AUSTRALIAN STANDARDS AND APPLICABLE BUILDING REGULATIONS
- o THIS DRAWING SHALL BE READ IN CONJUNCTION WITH ALL OTHER CLIENT'S AND CONSULTANT'S DRAWINGS & SPECIFICATIONS.
- O ALL DIMENSIONS ARE IN MILLIMETRES. DO NOT SCALE THESE DRAWINGS. DIMENSIONS MAY VARY FROM THESE STANDARD DRAWINGS. IT IS THE BUILDER'S RESPONSIBILITY TO VERIFY ALL DIMENSIONS, SETTING OUT DIMENSIONS SHALL BE TAKEN FROM THE CLIENT'S DETAIL SHOP DRAWINGS
- O THE STRUCTURE SHALL BE MAINTAINED IN A STABLE CONDITION DURING FRECTION AND NO PART SHALL BE OVERSTRESSED. TEMPORARY ROOF AND / OR WALL BRACING MAY BE REQUIRED DURING CONSTRUCTION.
- o FOR OPENING MODIFICATION, REFER TO RELEVANT DETAILS IN ASSEMBLY GUIDE
- o IT IS COMMON SENSE TO WORK SAFELY AND TO PROTECT YOURSELF AND OTHERS FROM ACCIDENTS ON SITE TO DO THIS YOU MUST ENSURE YOU HAVE IN PLACE SAFE WORK PRACTICES AND APPROPRIATE EQUIPMENT, SAFETY INVOLVES PERSONAL PROTECTION OF EYES, OF SKIN(FROM SUNBURN) AND OF HEARING(FROM NOISE). FALL PROTECTION MUST ALSO BE IN PLACE AS APPLICABLE INCLUDING SAFETY MESH, PERSONAL HARNESSES AND PERIMETER GUARDRAILS, IT IS RECOMMENDED THAT YOU FAMILIARIZE YOURSELE WITH APPLICABLE LAWS, REGULATIONS, RULES. GUIDELINES, CODES OF PRACTICE AND STANDARDS AND THAT YOU ADHERE STRICTLY TO THEM.

STRUCTURAL STEEL

- o ALL STEELWORK TO COMPLY WITH AS 4100 STEEL STRUCTURES CODE AND AS/NZS 4600 COLD-FORMED STEEL STRUCTURES CODE.
- o ALL STEEL FRAMING SHALL BE MANUFACTURED FROM HI-TENSILE HOT DIP ZINC COATED STEEL (G450 - G550) CONFORMING TO AS1397 u.n.o. AND INSTALLED TO MANUFACTURER'S INSTRUCTIONS
- o BRACING UNITS SHOULD BE SPLIT EQUALLY BETWEEN SIDES OF THE BUILDING.
- o TOPSPAN PURINS & GIRTS SHOULD BE CONTINUOUS LAPPED WITH

SELF DRILLING SCREWS

- o QUALITY AND MECHANICAL PROPERTIES OF STRUCTURAL SCREWS MUST COMPLY WITH AS3566.
- O ALL TEK SCREWS SHALL BE NO. 12 14 X 20 U.N.O o THE MINIMUM DISTANCE OF EDGE/END SCREWS MUST HAVE AN
- EDGE DISTANCE OF 1.5 X SCREW DIAMETER FROM THE EDGE. o THE MINIMUM DISTANCE OF SCREW TO SCREW SPACING MUST
- NOT BE LESS THAN 3 X SCREW DIAMETER BETWEEN ANY SCREWS.

HIGH TENSILE BOLTS

- O ALL BOLTS SHALL BE M16 / 8.8 / S U.N.O
- O CONNECTIONS WITH 8.8S BOLTS SPECIFIED ARE DESIGNED AS FRICTION TYPE JOINTS & BOLTS, NUTS & WASHERS SHALL COMPLY WITH THE RELEVANT REQUIREMENTS OF AS1252 o 8 8/S BOLTS TO BE INSTALLED IN ACCORDANCE WITH
- AS1511 & TENSIONED BY AN APPROVED METHOD TO PRODUCE THE FOLLOWING SHANK TENSIONS BOLT SIZE SHANK TENSION (kN) M12
- o FOR THIS DESIGN AN ACCEPTABLE TENSIONING METHOD IS SNUG TIGHT (PODGER SPANNER TIGHT) PLUS HALF A TURN.

CLADDING

- O ALL ROOF AND WALL CLADDING TO BE INSTALLED IN ACCORDANCE WITH AS1562 AND THE MANUFACTURER'S INSTRUCTIONS.
- O ROOF AND WALL CLADDING ARE STRUCTURAL DIAPHRAGM BRACINGS, UNDER NO CIRCUMSTANCES SHOULD THE CLADDING BE REMOVED WITHOUT WRITTEN APPROVAL FROM A PRACTICING STRUCTURAL ENGINEER

FOUNDATIONS

- o NO GEOTECHNICAL SITE INVESTIGATION IS PROVIDED. TWO STANDARD DESIGN OPTIONS ARE OFFERED:-
- o STIFF CLAY
- m CONFORMING TO AS2870.
- © SITE CLASSIFICATION CLASS M.
- MINIMUM SAFE BEARING CAPACITY 100kPa. ∞ SHAFT ADHESION 15kPa.
- o DENSE SAND
- © CONFORMING TO AS2870.
- m SITE CLASSIFICATION CLASS A / S.
- m MINIMUM SAFE BEARING CAPACITY 100kPa.
- SOIL ADHESION 10kPa.
- IE DIFFERENT SITE CONDITIONS ARE ENCOUNTERED A DIFFERENT. FOOTING DESIGN MAY BE REQUIRED
- o ALL VARIATIONS REQUIRE ADDITIONAL CERTIFIED DOCUMENTATION FROM A CONSULTING STRUCTURAL ENGINEER WHO ASSUMES FULL RESPONSIBILITY FOR THE DESIGN.

FOOTINGS AND SLAB

- STRIP AND REMOVE ALL TOPSOIL FROM THE SITE.
- o ALL FOOTINGS TO BE FOUNDED ON NATURAL GROUND. NO FOOTINGS TO BE FOUNDED ON FILL MATERIAL
- o FLOOR SLABS TO BE PLACED ON 50mm CONSOLIDATED CLEAN SAND LEVELLING BED. SLABS MAY BE PLACED ON 300mm MAXIMUM APPROVED GRANULAR FILL COMPACTED TO 98 % STANDARD COMPACTION.
- o THE EXCAVATION MUST BE BACKFILLED WITH MANUALLY RODDED TAMPED SOIL.

CONCRETE

- o ALL CONCRETE WORK TO BE IN ACCORDANCE WITH AS3600. 20MPa MINIMUM
- a FOOTING / SLAB STRENGTH F'c
- a SHRINKAGE LIMITED TYPE (SLICEMENT)
- MAXIMUM AGGREGATE SIZE
- o FLOOR SLABS TO BE CURED FOR 7 DAYS AFTER PLACEMENT BY MAINTAINING A CONTINUOUSLY WET SURFACE BY APPROVED METHODS
- o PROVIDE TOOLED OR CUT CONTROL JOINTS IN FLOOR SLABS ON GRIDLINES AS INDICATED

STRUCTURAL STEELWORK SCHEDULE FOOTING SCHEDULE - CLAY

MARK	DESCRIPTION	SECTION	
C1	COLUMN UNCLAD FRAME	C15015	
C2		C15010	
C3	COLUMN - END	C15015 (2)*	
R1	RAFTER UNCLAD FRAME	C15015	
R2	RAFTER CLAD FRAME	C15010	
DH1(I)	RD HEAD - SIDE INT. BAY	TS6160+TS6160	
RMSI	RD SIDE - POST (INT. BAY)	C15010	
F1	FASCIA	0.75 FB	
P1	PURLINS	TopSpan/6175 @ 1250	
G1	GIRTS - SIDE	TopSpan/6160 @ 1190	
G2	GIRTS - END	TopSpan/6160 @ 1190	
rbr	ROOF BRACING	DIAPHRAGM	
wbr	WALL BRACING	DIAPHRAGM	
fbr	FLY BRACE - ROOF	95 x 0.6 STRAP (4)**	
fbc	FLY BRACE - COLUMN	95 x 0.6 STRAP (1)***	
PEEER TO DOS DEE DOON NR. DQ 2-E-R2 5			

- REFER TO RDS REF DCON-NR D9 2-F-R2 5
- * QUANTITY IN BRACKETS REFERS TO NUMBER OF ELEMENTS PER END FRAME ** QUANTITY IN BRACKETS REFERS TO NUMBER OF FLEMENTS PER ROOF FRAME
- ** QUANTITY IN BRACKETS REFERS TO NUMBER OF ELEMENTS PER COLUMN

MARK	DESCRIPTION	SIZE
PF1	PAD FOOTING (DxWxW)	600x600x600
PF2		500x500x500
PF3		400x400x400
SF1	SLAB FOOTING (DxWxW)	200x200x200
S1	SLAB ON GRADE	100RC SLAB SL62T
	,	

DESIGN LOADING

o THE STRUCTURAL COMPONENTS SHOWN ON THESE DRAWINGS HAVE BEEN DESIGNED FOR THE FOLLOWING LOAD CONDITIONS COMPLYING WITH AS/NZS 1170.0, 1, 2, 3:-

ROOF DEAD LOAD	SELF WEIGHT ONLY
ROOF LIVE LOAD	(1.8/A+0.12) BUT NOT LESS
	THAN 0.25kPa AND 1.1kN
WIND LOAD REGION	A
TERRAIN CATEGORY	2
Ms	1.0
Mt	1.0
INTERNAL PRESSURE	Cpi = -0.3 or 0.0 (ENCLOSED)
COEFFICIENTS	Cpi = -0.65 or +0.7 (OPEN)
GROUND SNOW LOAD So	0.5 kPa

o ALL DOORS AND WINDOWS SHALL HAVE THE SAME CYCLONIC WIND LOAD RATING AS THE REST OF THE BUILDING ENVELOPE, INCLUDING RESISTANCE TO FLYING DEBRIS AS SPECIFIED IN AS1170 2:2011 AND AS/NZS 4505-2012 DOORS AND WINDOWS SHALL BE CLOSED DURING STORMS, DOORS SHALL BE INSTALLED WITH WIND LOCKS IN CYCLONIC AREAS. SUPPORTING DOCUMENTATION INCLUDING TEST REPORTS SHALL BE AVAILABLE FROM DOORS AND WINDOWS MANUFACTURERS TO CONFIRM LOAD RATING AND ENSURE COMPLIANCE WITH ABOVE MENTIONED STANDARDS AND BCA DOORS ARE ALSO REQUIRED TO BE SUPPLIED WITH A STICKER THAT SHOW A RANGE OF INFORMATION INCLUDING THE DESIGN PRESSURE OF THE DOC

ANNEXE 1 STRUCTURAL STEELWORK SCHEDULE FOOTING SCHEDULE - CLAY

MARK	DESCRIPTION	SECTION	
C1	COLUMN UNCLAD FRAME	C15010	
R1	RAFTER UNCLAD FRAME	C15015	
F1	FASCIA	0.75 FB	
P1	PURLINS	TopSpan/6175 @ 1275	
rbr	ROOF BRACING	DIAPHRAGM	
wbr	WALL BRACING	DIAPHRAGM	
fbr	FLY BRACE - ROOF	95 x 0.6 STRAP (2)*	
DEFEN TO DOC DEE DAY DO DO S			

REFER TO RDS REF DAN-RO-B2.5 * QUANTITY IN BRACKETS REFERS TO NUMBER OF ELEMENTS PER ROOF FRAME

ANNEXE 1

MARK	DESCRIPTION	SIZE
PF1A	PAD FOOTING (DxWxW)	550x550x550
PF1B		700x700x700
PF2B		575x575x575
SF1A	SLAB FOOTING (DxWxW)	250x250x250
S1	SLAB ON GRADE	100RC SLAB SL62T

DRAWING SCHEDULE


- o 374334-ES ENGINEERING SCHEDULE
- o 374334-GA GENERAL ARRANGEMENT
- o 374334-RSP RC SLAB PLAN
- o ENG-DELUXE-01 ENGINEERING LAYOU

o ENG-DELUXE-02 - CONNECTION DETAIL:

ENGINEERING SCHEDULE

DRAWING NUMBER

PAGE 374334-ES 1/1

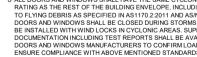

ACCORDING TO AS/NZS 4505-2012 REQUIREMENTS.

PRODUCT RANGE

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REV DESCRIPTION DATE trading as RANBUILD DRAWN BY RDS 26/08/2017

DELUXE




I CERTIFY THAT THE DESIGN OF THIS STEEL FRAMED BUILDING IS STRUCTURALLY ADEQUATE, MEETS SERVICARII ITY REQUIREMENTS AND COMPLIES WITH THE RELEVANT REGULATIONS WITH ALL AMENDMENTS


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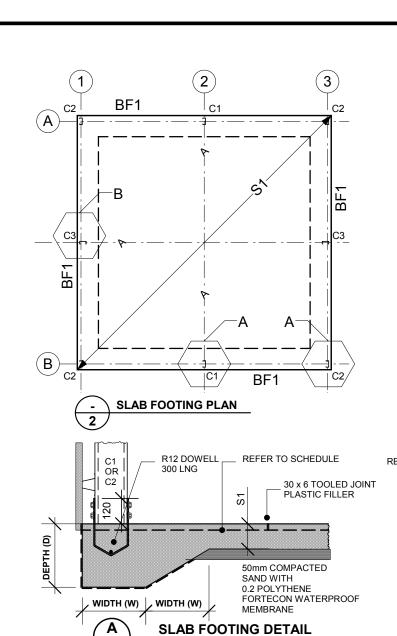
I FURTHER CERTIFY THE PROPOSED STEEL FRAMED BUILDING WILL BE STRUCTURALLY ADEQUATE WHEN CONSTRUCTED TO GOOD BUILDING PRACTISES, IN ACCORDANCE TO RANBUILD ASSEMBLY GUIDE AND THESE


BlueScope Lysaght Technology
DRAWTINGS: APPROVED 24/08/2017.

EXANDER FILONOV MIFAust CPFng NPFR 1296608 (Structural), RPEQ 8094, CC4719P, EC27759, 24332ES



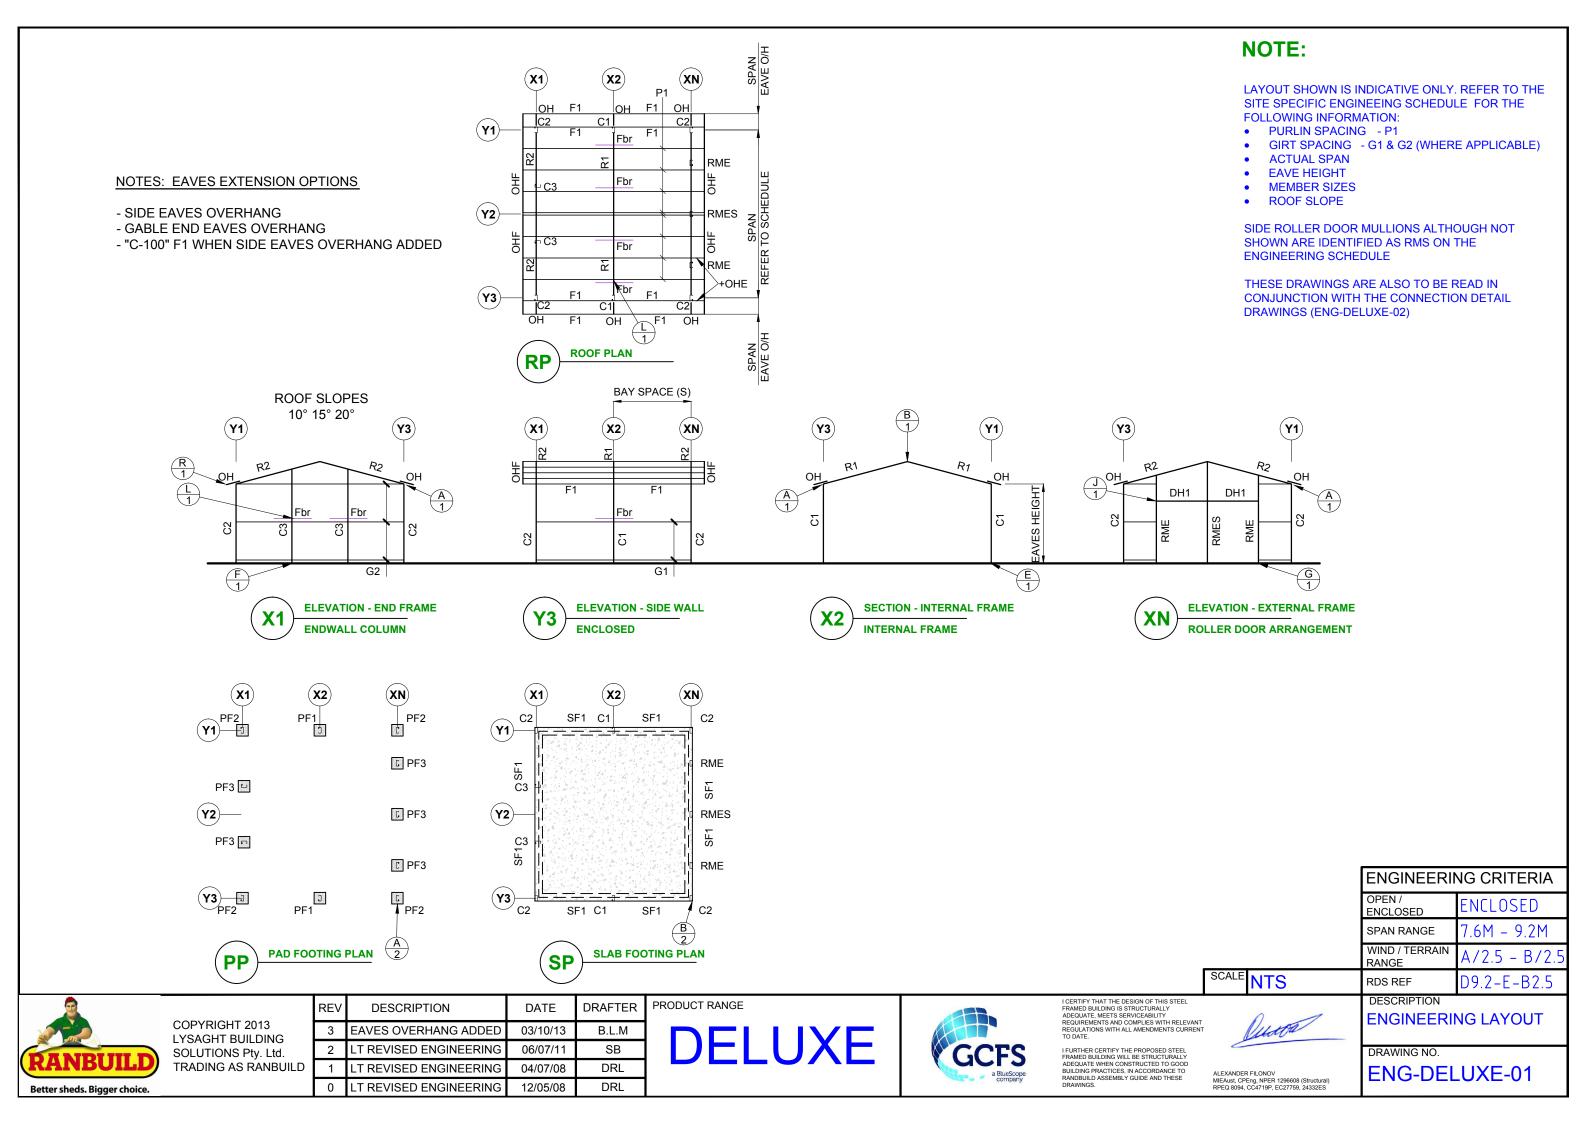

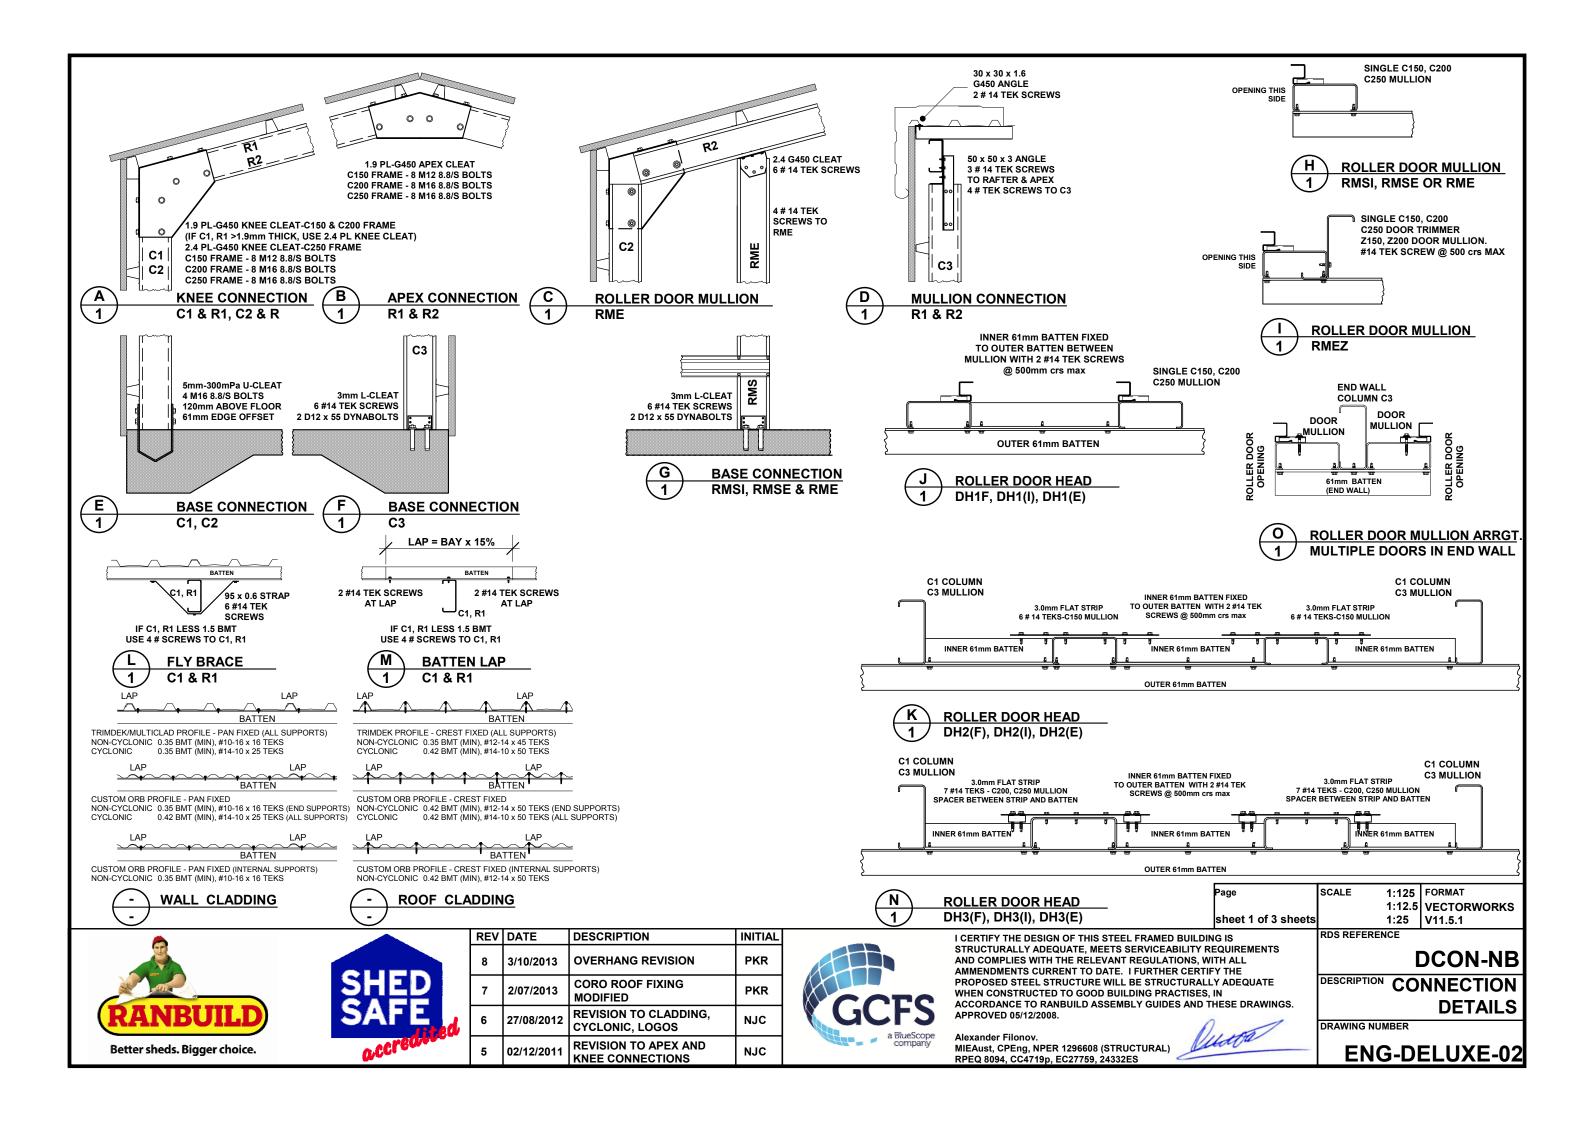

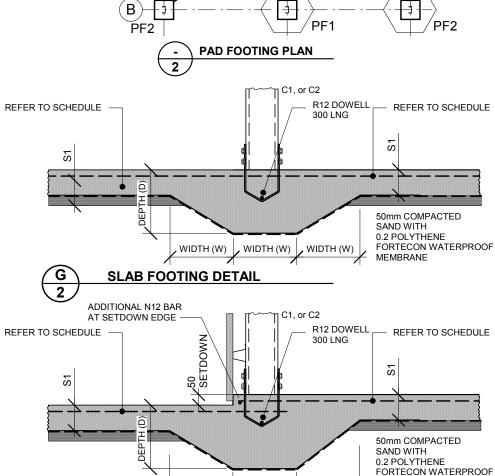

WIDTH (W) | WIDTH (W) | WIDTH (W)

(2)

PF1

3

PF2


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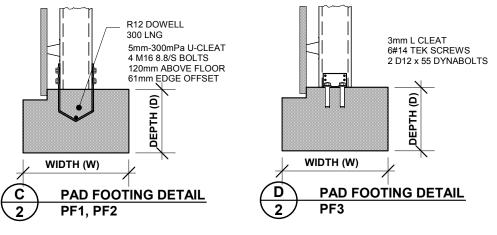
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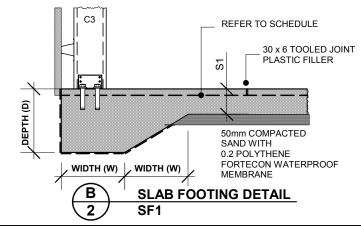
PF2

PF3

(A)





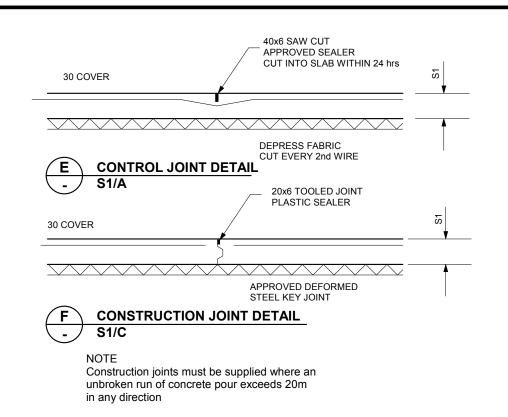

H SLAB FOOTING SETDOWN DETAIL
TOP MESH TO LAP 300mm MINIMUM

Page SCALES 1:125 FORMAT
1:12.5 VECTORWORKS
sheet 2 of 3 sheets 1:25 V11.5.1



2

SF1



REV	DATE	DESCRIPTION	INITIAL
9	7/04/2014	SLAB REVISION	PKR
8	3/10/2013	OVERHANG REVISION	PKR
7	22/07/2013	GENERAL REVISION	PKR
6	27/08/2012	REVISION TO CLADDING, CYCLONIC, LOGOS	NJC



MEMBRANE

I CERTIFY THE DESIGN OF THIS STEEL FRAMED BUILDING IS STRUCTURALLY ADEQUATE, MEETS SERVICEABILITY REQUIREMENTS AND COMPLIES WITH THE RELEVANT REGULATIONS, WITH ALL AMMENDMENTS CURRENT TO DATE. I FURTHER CERTIFY THE PROPOSED STEEL STRUCTURE WILL BE STRUCTURALLY ADEQUATE WHEN CONSTRUCTED TO GOOD BUILDING PRACTISES, IN ACCORDANCE TO RANBUILD ASSEMBLY GUIDES AND THESE DRAWINGS. APPROVED 05/12/2008.

Alexander Filonov.
MIEAust, CPEng, NPER 1296608 (STRUCTURAL)
RPEQ 8094, CC4719p, EC27759, 24332ES

1:25 V11.5.1


RDS REFERENCE

DCON-NB
DESCRIPTION CONCRETE

SCRIPTION CONCRETE DETAILS

RAWING NUMBER

ENG-DELUXE-02

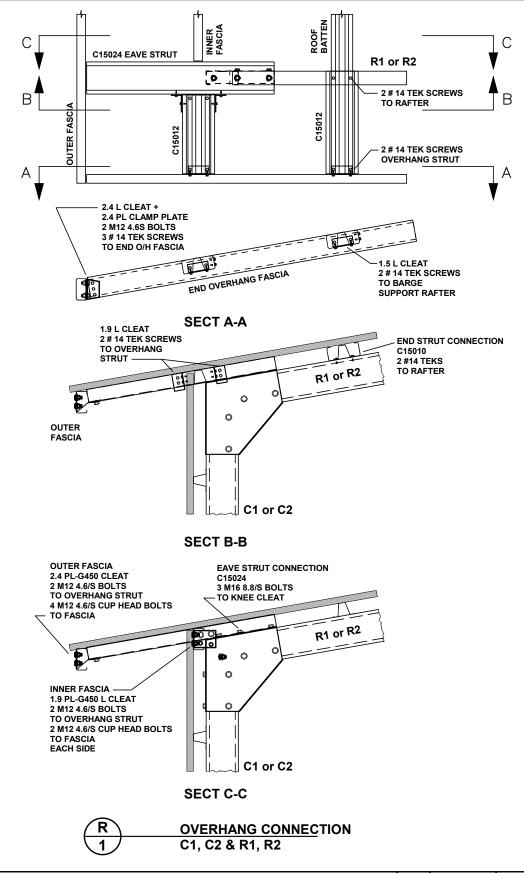

REV DATE **DESCRIPTION** INITIAL OVERHANG REVISION PKR



I CERTIFY THE DESIGN OF THIS STEEL FRAMED BUILDING IS STRUCTURALLY ADEQUATE, MEETS SERVICEABILITY REQUIREMENTS AND COMPLIES WITH THE RELEVANT REGULATIONS, WITH ALL AMMENDMENTS CURRENT TO DATE. I FURTHER CERTIFY THE PROPOSED STEEL STRUCTURE WILL BE STRUCTURALLY ADEQUATE WHEN CONSTRUCTED TO GOOD BUILDING PRACTISES, IN ACCORDANCE TO RANBUILD ASSEMBLY GUIDES AND THESE DRAWINGS. APPROVED 05/12/2008.

Alexander Filonov. MIEAust, CPEng, NPER 1296608 (STRUCTURAL) RPEQ 8094, CC4719p, EC27759, 24332ES

1:12.5 VECTORWORKS 1:25 V11.5.1

RDS REFERENCE

SCALES

sheet 3 of 3 sheets

DCON-NB


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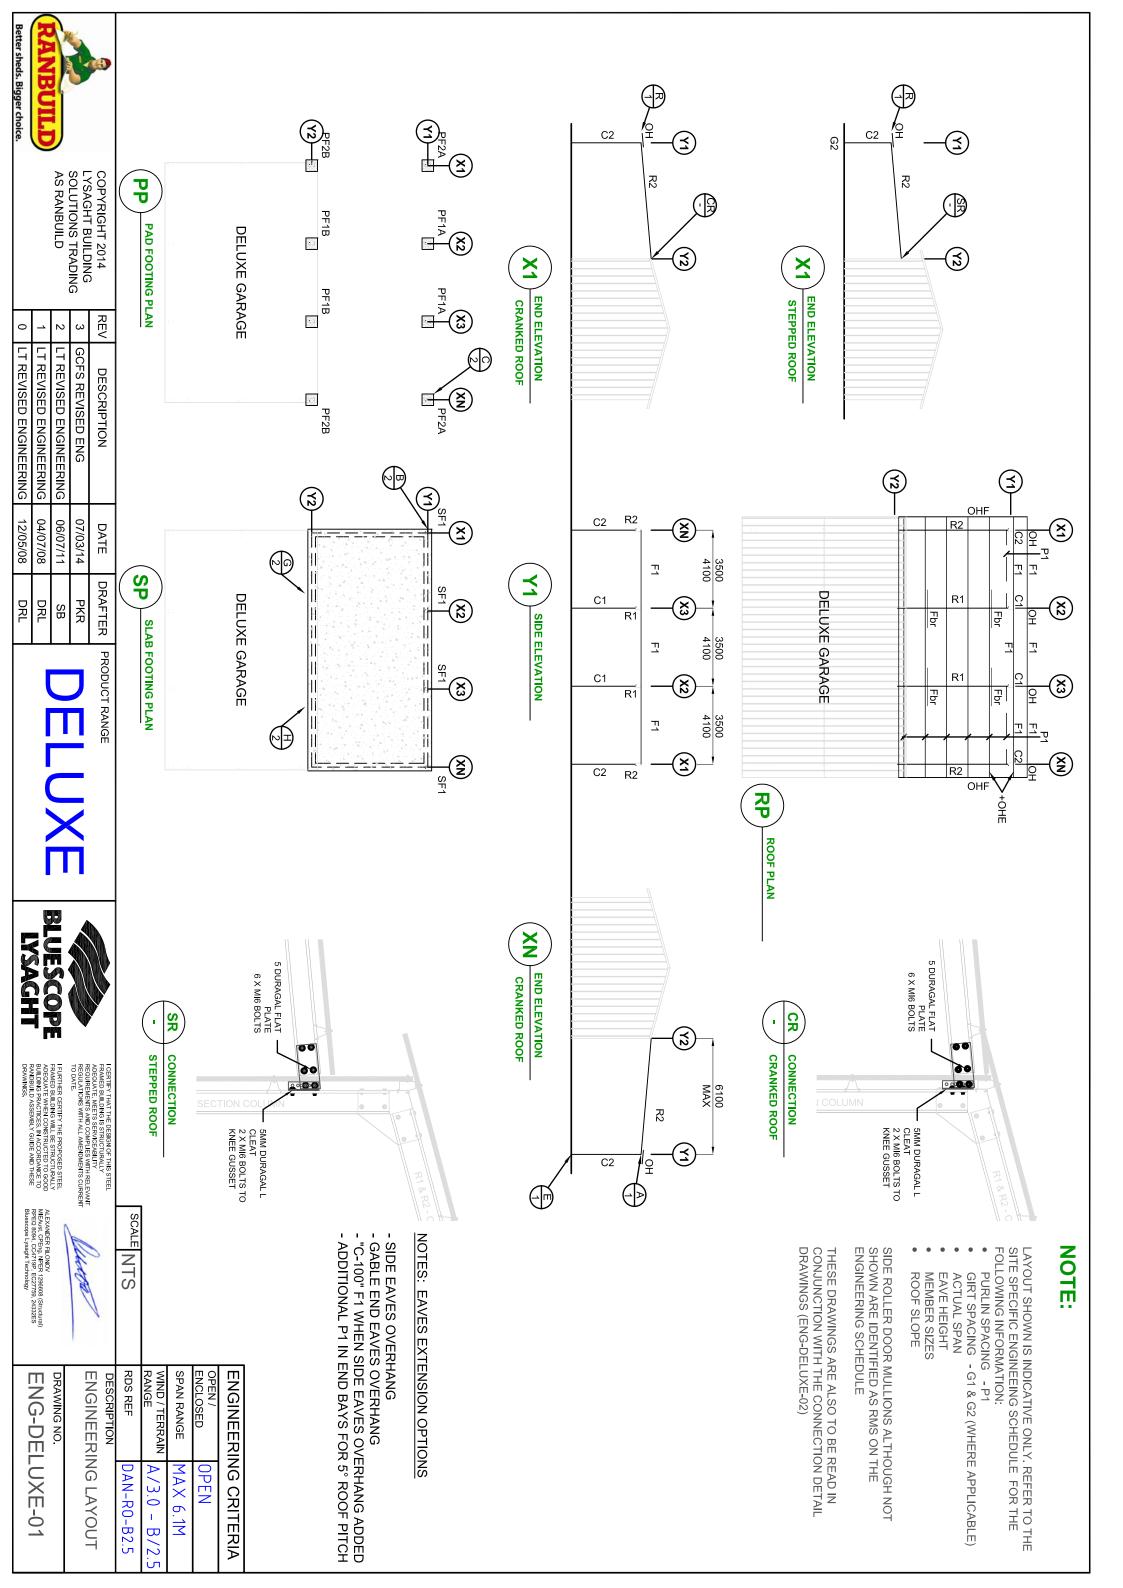
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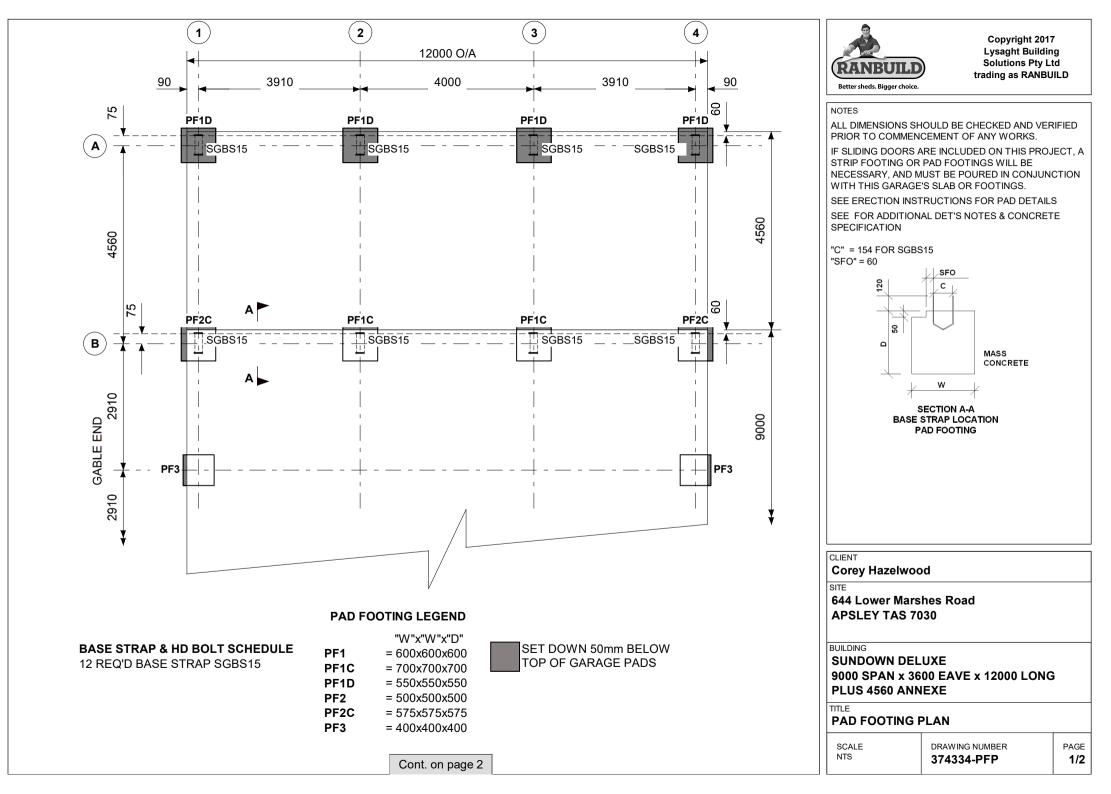
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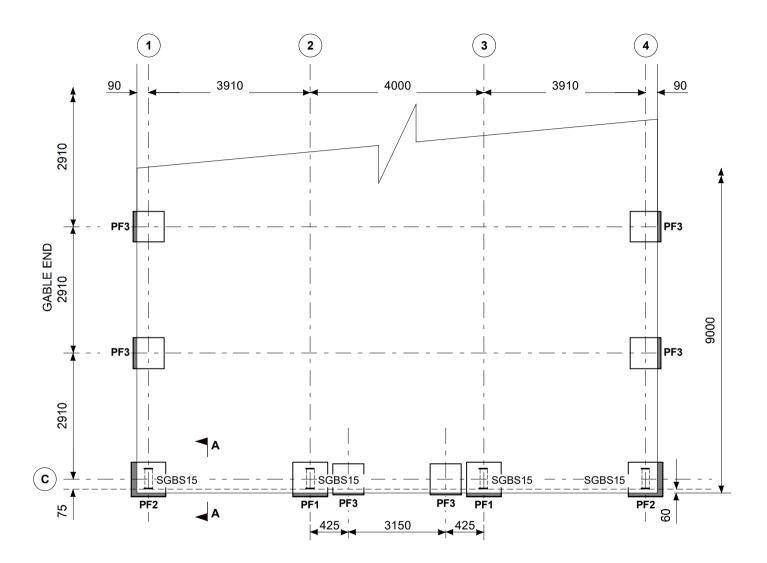
ENG-DELUXE-02









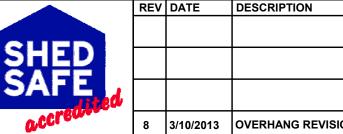



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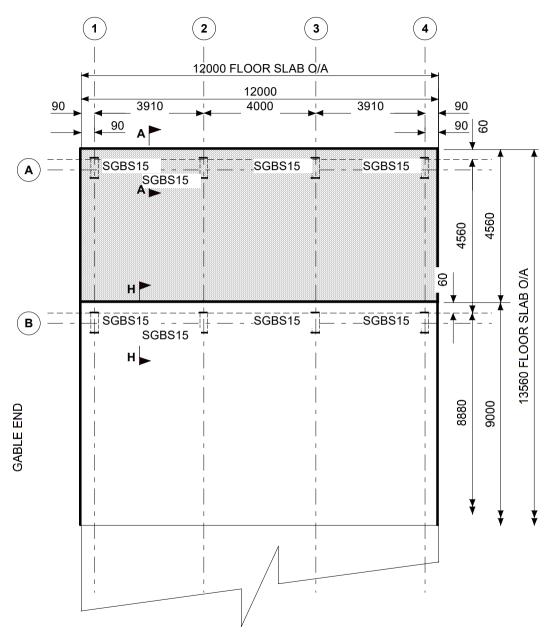
SCALE NTS

DRAWING NUMBER

PAGE **2/2**

374334-PFP

SET DOWN ALL SHADED AREAS 50mm



BASE STRAP & HD BOLT SCHEDULE 12 REQ'D BASE STRAP SGBS15

Cont. on page 2



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NOTES


ALL DIMENSIONS SHOULD BE CHECKED AND VERIFIED PRIOR TO COMMENCEMENT OF ANY WORKS.

IF SLIDING DOORS ARE INCLUDED ON THIS PROJECT, A STRIP FOOTING OR PAD FOOTINGS WILL BE NECESSARY, AND MUST BE POURED IN CONJUNCTION WITH THIS GARAGE'S SLAB OR FOOTINGS.

SEE ERECTION INSTRUCTIONS FOR SECTION & SLAB DETAILS

SEE FOR ADDITIONAL DET'S NOTES & CONCRETE SPECIFICATION

"D" = 250 "W" = 250 "C" = 154 FOR SGBS15 "S1" = 100 "SFO" = 60

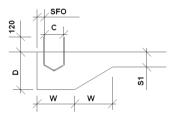

SECTION A-A BASE STRAP LOCATION SLAB

CLIENT

Corey Hazelwood

SITE

644 Lower Marshes Road APSLEY TAS 7030

BUILDING

SUNDOWN DELUXE 9000 SPAN x 3600 EAVE x 12000 LONG PLUS 4560 ANNEXE

TITLE


RC SLAB PLAN

SCALE NTS DRAWING NUMBER 374334-RSP

PAGE 1/2



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SCALE NTS

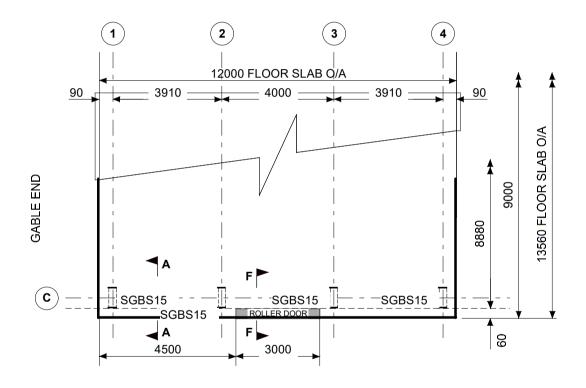PAGE **2/2**



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NOTES

ALL MODIFICATIONS REQUESTED ON THE STRUCTURAL ADEQUACY CERTIFICATE MUST BE MADE IN ADDITION TO THIS PLAN

SEE BILL OF MATERIALS FOR MEMBER DESCRIPTION

SEE DRG N° 374334-CLD FOR CLADDING LOCATION DIAGRAM

FOR EXACT BRACING QUANTITIES AND TYPES PLEASE REFER TO THE ENGINEERING SCHEDULE. FOR LOCATING AND FIXING, REFER TO THE ASSEMBLY GUIDE.

IF SLIDING DOORS ARE PRESENT ON THIS PROJECT, REFERENCE TO THE SLIDING DOOR ASSEMBLY GUIDE SUPPLEMENT WILL BE NECESSARY FOR LOCATION OF ANY SLIDING DOOR FRAMING MEMBERS. FOR CONFIRMATION OF SLIDING DOOR AND DOOR TRACK LOCATIONS, REFER TO FLOOR PLAN AND ELEVATION DRAWING.

CLIENT

Corey Hazelwood

SITE

644 Lower Marshes Road
APSLEY TAS 7030

BUILDING

SUNDOWN DELUXE 9000 SPAN x 3600 EAVE x 12000 LONG PLUS 4560 ANNEXE

TITLE


STEELWORK MARKING DIAGRAM

SCALE A4 SHEET 1:125 DRAWING NUMBER 374334-SMP

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SCALE A4 SHEET 1:125

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PAGE

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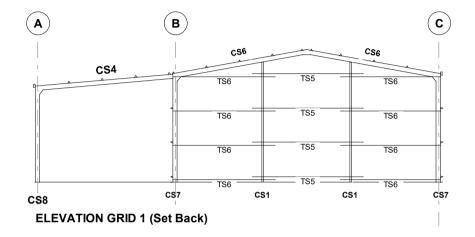
3 2 TS9 TS8 TS9 TS3 TS3 TS1 TS3 TS3 TS1 TS3 TS3 TS1 TS3 TS3 TS1 CS5 CS5 CS7 **ELEVATION GRID B** FS1 FS1 FS1 CS8 CS8 CS8 **ELEVATION GRID A**

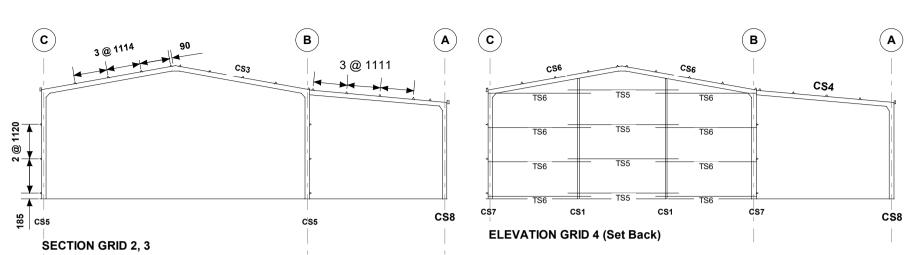SCALE A4 SHEET 1:125

DRAWING NUMBER 374334-SMP

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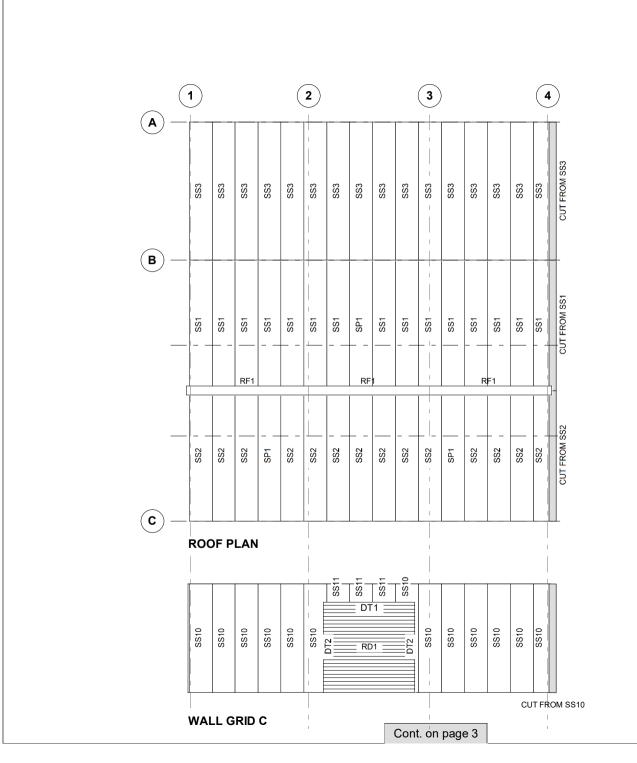


SCALE A4 SHEET 1:125

DRAWING NUMBER

PAGE 374334-SMP

4/4





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NOTES

SEE BILL OF MATERIALS FOR CLADDING DESCRIPTION

SEE DRG N° 374334-SMP FOR STEELWORK MARKING DIAGRAM

Cont. on page 2

CLIENT

Corey Hazelwood

SITE

644 Lower Marshes Road APSLEY TAS 7030

BUILDING


SUNDOWN DELUXE 9000 SPAN x 3600 EAVE x 12000 LONG PLUS 4560 ANNEXE

TITLE

CLADDING LOCATION DIAGRAM

SCALE A4 SHEET 1:125 DRAWING NUMBER 374334-CLD

PAGE 1/3

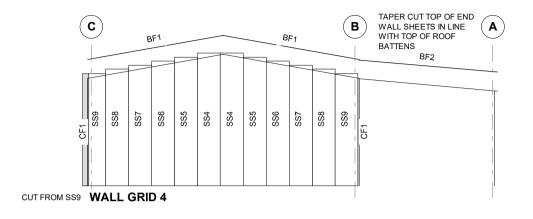





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PAGE **2/3**





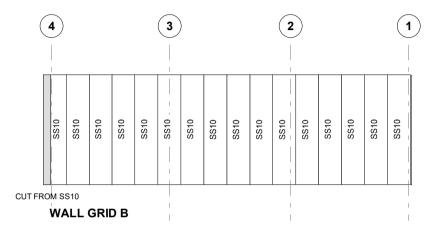

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SMEEKES DRAFTING PTY LTD

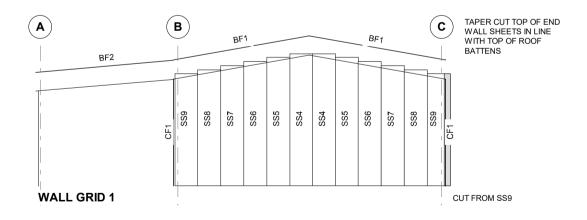ABN 89 056 706 640

12 Warwick Street HOBART TAS 7000

Phone: (03) 62 34 6185 Mobile: 0418 352 503

Email: admin@smeekesdrafting.com

www.smeekesdrafting.com

Building Designer Licence Nos. 723026951, 619068752 & CC6621

19 June 2020

Central Highlands Council
Development & Environmental Services
Alexander Street, Bothwell, TAS 7030

Re: Response to RFI (DA 2020 / 00033)
Proposed Change of Use – Farm Shed to Distillery: 644 Lower Marshes Road, Apsley

Dear Kathy,

Can we please amend the change of use from Farm Shed to Whiskey Distillery to Farm Shed to Distillery.

Please find further information in support of the application. Our client is seeking a change of use from an existing colorbond farm shed (refer to shed plans by Ranbuild – Drawing number 374334-GA for construction and engineering details) to distillery with online sales and postage.

The distillery will be staffed by one – two people with hours of operation between 9am – 5pm. When distilling some earlier starts and late finishes may be required. On average, the distillery will operate one week a month.

The distilling equipment is 1x 100L copper pot still, 4x 1000L fermentation tanks, 1x 1300L mash ton and an existing farm tractor for loading & unloading.

Vehicle Movements:

Staff Vehicle – One vehicle on average seven times per month when the distillery is operating. Delivery vehicles – One utility or small truck delivery vehicle once per eight weeks. Visitors will be by booking only with the primary distribution via online sales and postage.

The Cellar door can also be visited via booking only with light prepacked snacks, water and soft drink being provided at the same time. Currently no signage will be visible from the street.

In response to the performance criteria P1 of standard 26.3.3 for Discretionary Use in the Rural Resource Zone;

(a) Existing agricultural use – Mixed farming.



- (b) Proposed non-agricultural use Distillery with primary online sales and distribution. Both uses benefit as the mixed farming produces ingredients for the distillery and the by-product from the distilling can be used as feed for livestock.
- (c) Refer to the Smeekes Drafting Drawing HAZELWOOD-001 & 002 for site setback and separation between proposed and existing agricultural use zones.
- (d) As the proposed distillery is wholly contained within the existing farm shed and no visible signage from the street, there is no adverse impacts on the amenity from the existing or likely agricultural use.

Please refer to the below images on the existing farm shed and surrounding area.

Existing Aerial Image (Source: Google Maps)



Existing Farm Shed





View from Farm Shed to Lower Marshes Road



View from Farm Shed to Existing Residential Dwelling at 644 Lower Marshes Road, Apsley



Sincerely,

Roland Smeekes

(Director)